

8

7

6

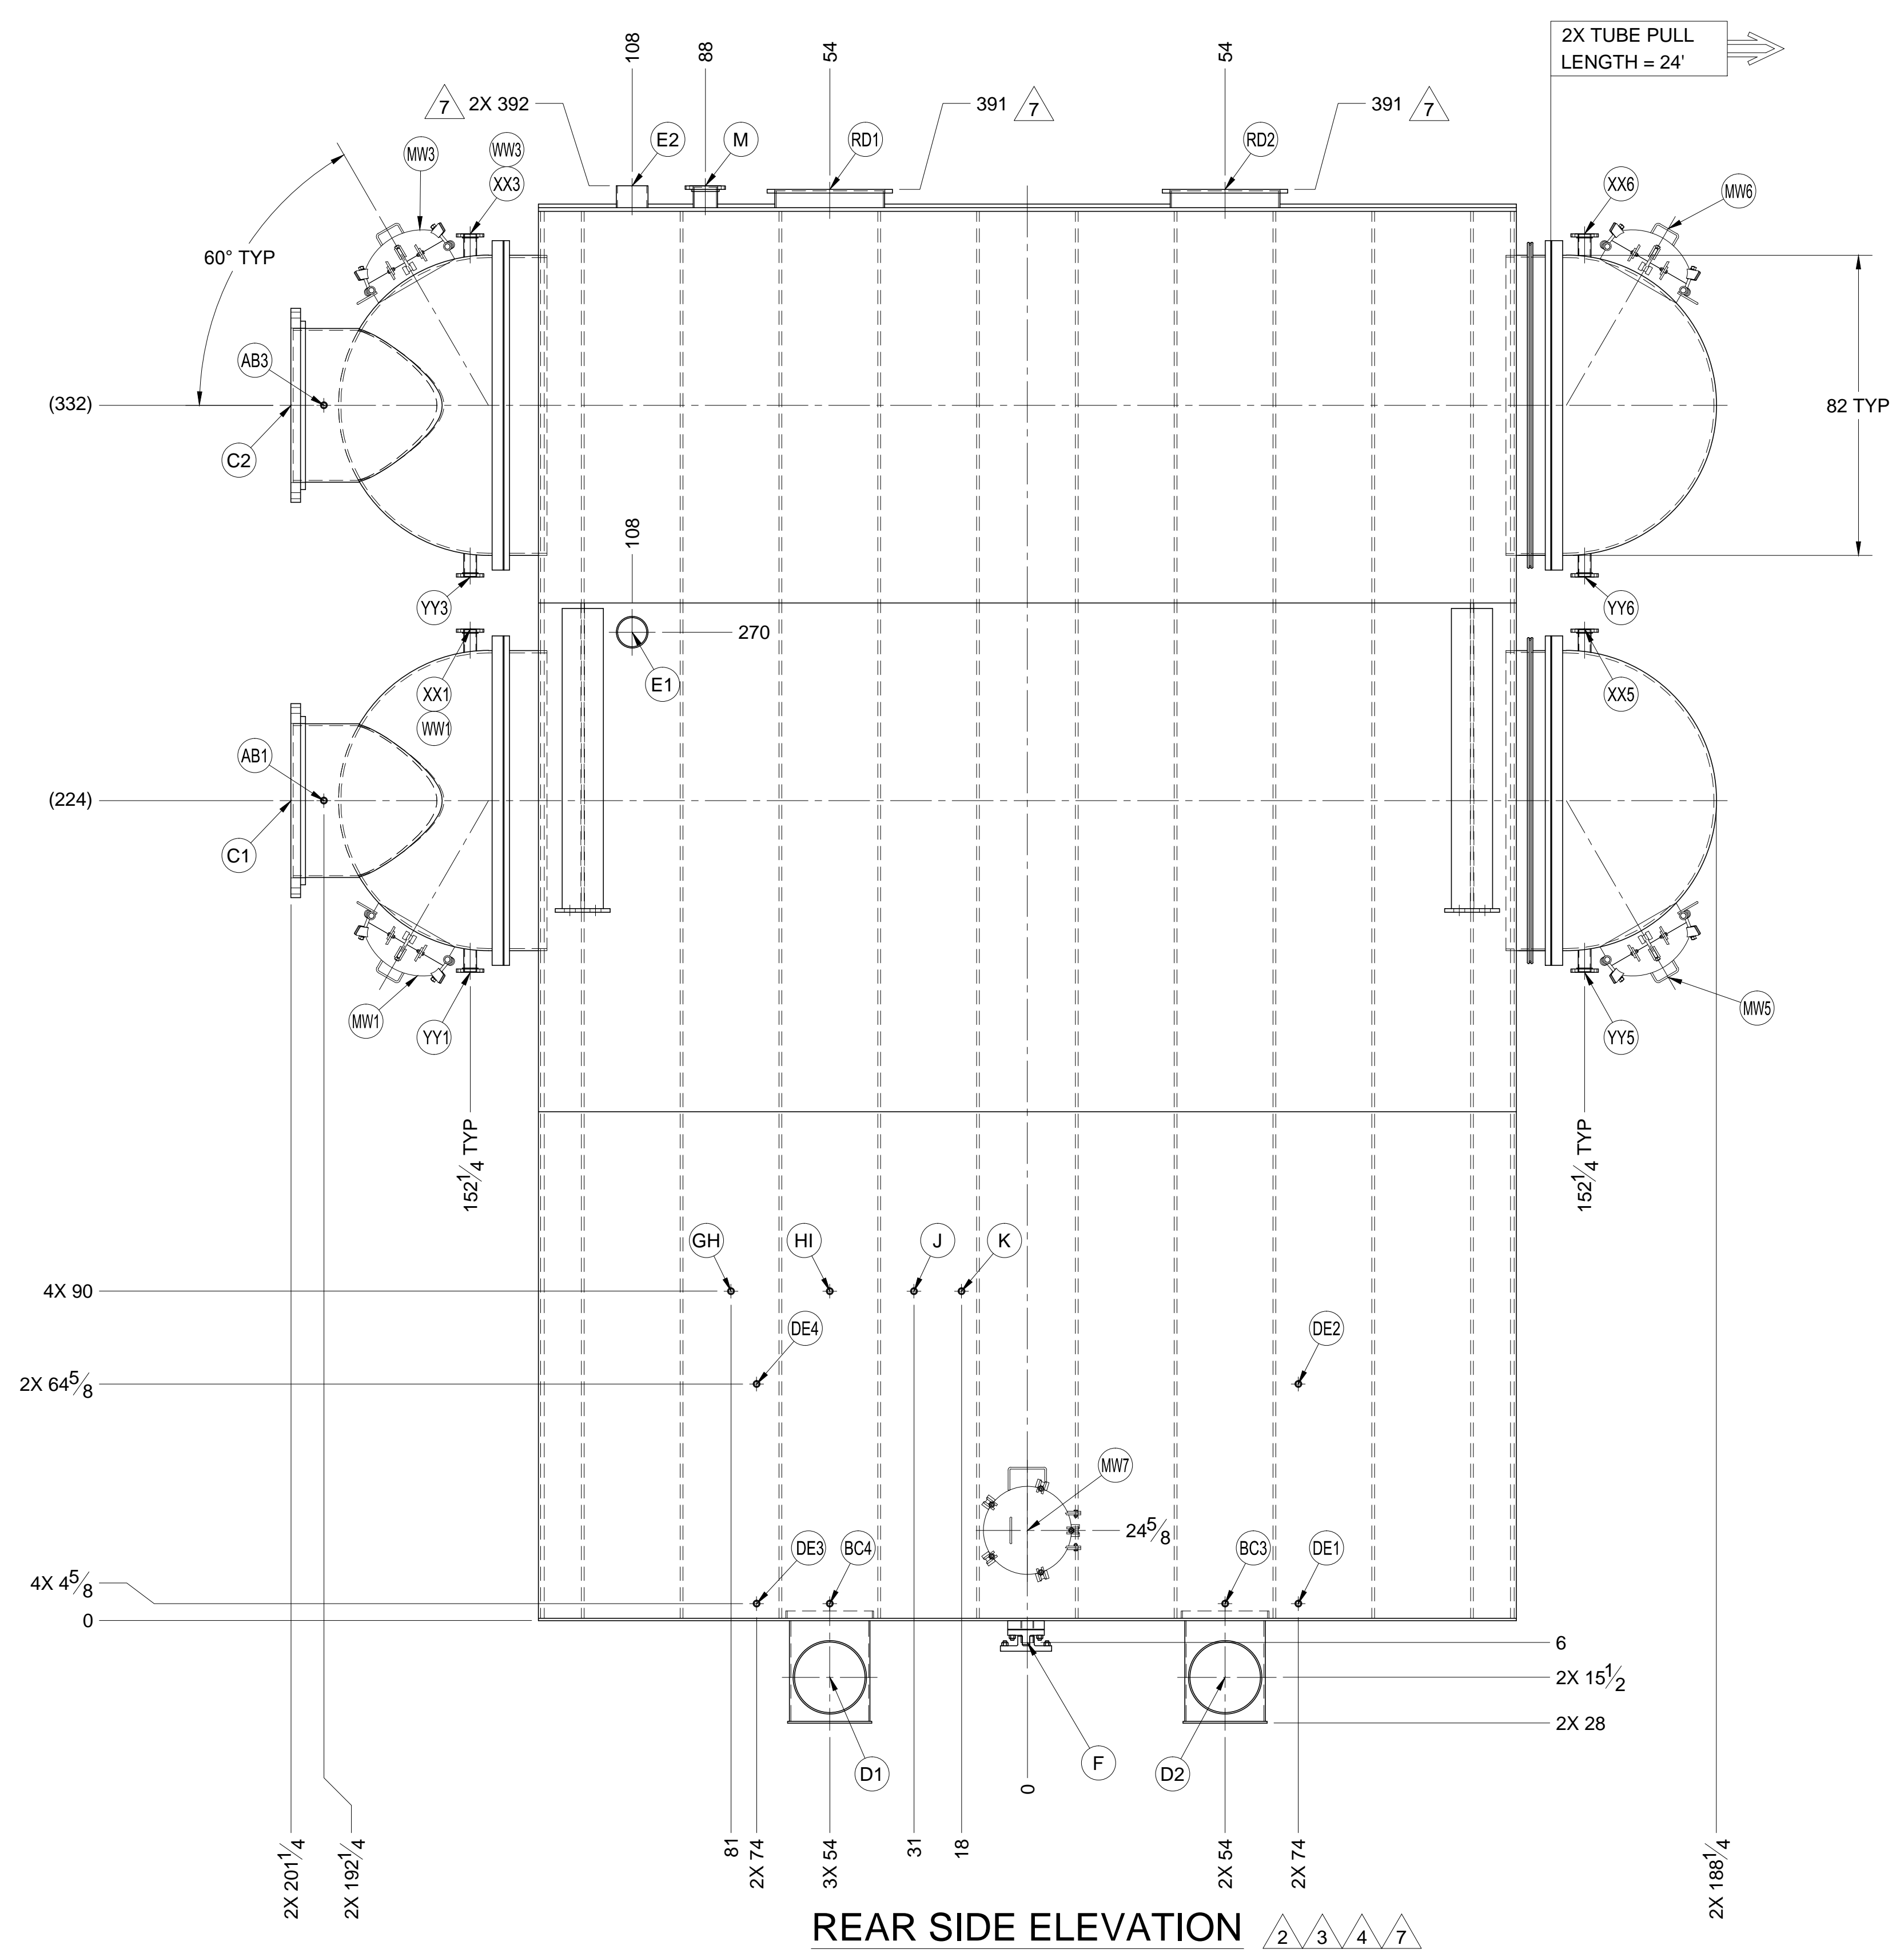
5


4

3



2

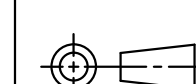
1




**REAR SIDE ELEVATION**   
 SCALE 1:30  
 EAST SIDE (LOOKING WEST AT TURBINE).

UNLESS OTHERWISE SPECIFIED  
 ALL DIMENSIONS ARE IN INCHES.  
 BRACKETED [ ] DIMENSIONS ARE IN mm.  
 DO NOT SCALE DRAWING.  
 INTERPRET DIMENSIONING AND  
 TOLERANCING PER ASME Y14.5M-1994.  
 TOLERANCES PER APPLICABLE  
 H.E.I. STANDARD.

 REVISION IDENTIFIER  
 NOZZLE IDENTIFIER

 THIRD ANGLE PROJECTION

THIS DRAWING IS THE INTELLECTUAL PROPERTY OF HOLTEC INTERNATIONAL. IT IS PROVIDED TO THE RECIPIENT UNDER THE EXPLICIT CONDITION THAT IT WILL NOT BE DUPLICATED IN WHOLE OR PART, OR GIVEN TO OTHERS WITHOUT WRITTEN CONSENT OF HOLTEC INTERNATIONAL.

 <b>HOLTEC INTERNATIONAL</b> POWER PLANT COMPONENTS DIVISION HOLTEC CENTER 555 LINCOLN DRIVE WEST MARLTON, NJ 08053 (USA)		PROJECT / CLIENT <b>GAINESVILLE RENEWABLE ENERGY CENTER, FAGEN, INC.</b>	
CLIENT JOB NO. 104009		ENGINEER ZACHRY ENGINEERING CORPORATION	
CLIENT P.O. NO. 554652		LOCATION GAINESVILLE, FLORIDA	
CLIENT DOC. NO. O-A014200-SPCG481116	SIZE D	PROJECT NO. 2135	DRAWING NO. 8284
		SHEET 4 OF 8	REV. 7
FILE PATH: G:\PROJECTS\2135-0-DRAWINGS\GAI\8284_REV 7 PLOTTED July 30, 2012 1:57:01 PM BY TY PETRAKIS			

8

7

6

5

4

3

2

1